



DEMOLITION NOTE:


-ALL SERVICES TO THE EXISTING BUILDING ARE TO BE DISCONNECTED BEFORE THE START OF DEMOLITION.

-CONTRACTOR TO COORDINATE THE DISCONNECTS WITH THE APPROPRIATE UTILITY PROVIDER.

-WATER AND WASTEWATER SERVICES ARE TO BE PLUGGED/CAPPED IN ACCORDANCE WITH LOCAL CODE. CONTRACTOR TO COORDINATE WITH THE CITY OF BRYAN PUBLIC WORKS DEPARTMENT.

-ALL EXISTING YARD LINES ARE TO BE REMOVED ONCE THEIR DISCONNECTION HAS BEEN MADE.

-ALL EXISTING TACO BELL SIGNS, MENU BOARDS AND LIGHT POLES ARE TO BE REMOVED. CONTRACTOR TO COORDINATE THE REMOVAL WITH AUSTACO.

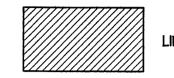

LIMITS OF DEMOLITION

2626 2655

AVENUE 77803 BELL S 920 Bl

DEMOLITION PLAN

ALL RESPONSIBILITY FOR THE ADEQUACY OF THESE PLANS REMAINS WITH THE ENGINEER WHO PREPARED THEM. IN REVIEWING THESE PLANS, THE CITY OF AUSTIN MUST RELY UPON THE ADEQUANCE OF THE WORK OF THE DESIGN ENGINEER.

Fisher . Hagood Civil and Structural Engineering


> "Innovation engineered from the ground up". One Chisholm Trail, Sulte 5200 Round Rock, TX 18681 Phone (512) 244-1546 Fax (512) 388-3648

DATE ISSUED: 06/08/06
ISSUED FOR: AGENCY REVIEW THE SEAL APPEARING ON THIS DOCUMENT W
AUTHORIZED BY TERRY R. HAGOOD, P.E.
52960
THIS DRAWING MAY NOT BE MODIFIED
WITHOUT THE EXPRESS WRITTEN CONSENT
THE ENGINEER, AND THEN ONLY IN
ACCORDANCE WITH THE RULES OF THE TEX
ENGINEERING PRACTICE ACT. NOTICE:

1. THIS DOCUMENT, THE IDEAS AND DESIGN INCORPORATED HEREIN ARE AND SHALL REMAIN THE PROPERTY OF FISHER HAGOOD INC. THESE DOCUMENTS ARE NOT TO BE USED OR ALTERED, IN WHOLE OR IN PART, FOR OTHER THAN THE ORIGINAL INTENDED USE, NOR ARE THEY TO BE ASSIGNED TO ANY THIRD PARTY WITHOUT WRITTEN PERMISSION FROM FISHER HAGOOD, INC. 2. BY THE ACT OF SUBMITTING A BID FOR THE PROPOSED CONTRACT, THE BIDDER WARRANTS THAT THE BIDDER, AND ALL SUBCONTRACTORS AND MATERIAL SUPPLIERS FE INTENDS TO USE HAVE CAREFULLY AND THOROUGHLY REVIEWED THE DRAWINGS AND SPECIFICATIONS AND OTHER CONSTRUCTION CONTRACT DOCUMENTS AND HAVE FOUND THEM COMPLETE AND FREE FROM ANY AMBIGUITIES AND SUFFICIENT FOR THE PURPOSE INTENDED. THE BIDDER FURTHER WARRANTS THAT TO THE BEST OF HIS OR HIS SUBCONTRACTORS AND MATERIAL SUPPLIERS KNOWLEGGE ALL MATERIALS AND PRODUCTS SPECIFIED OR INDICATED HEREIN ARE ACCEPTABLE FOR ALL APPLICABLE CODES AND AUTHORITIES. TERRY R. HAGOOD

PROJECT NO. 25120
CAD FILE 25120C20
DRAWN BY CMB
CHECKED BY TRH DATE: SCALE: 06/08/06 AS NOTED **C20**

REVISIONS

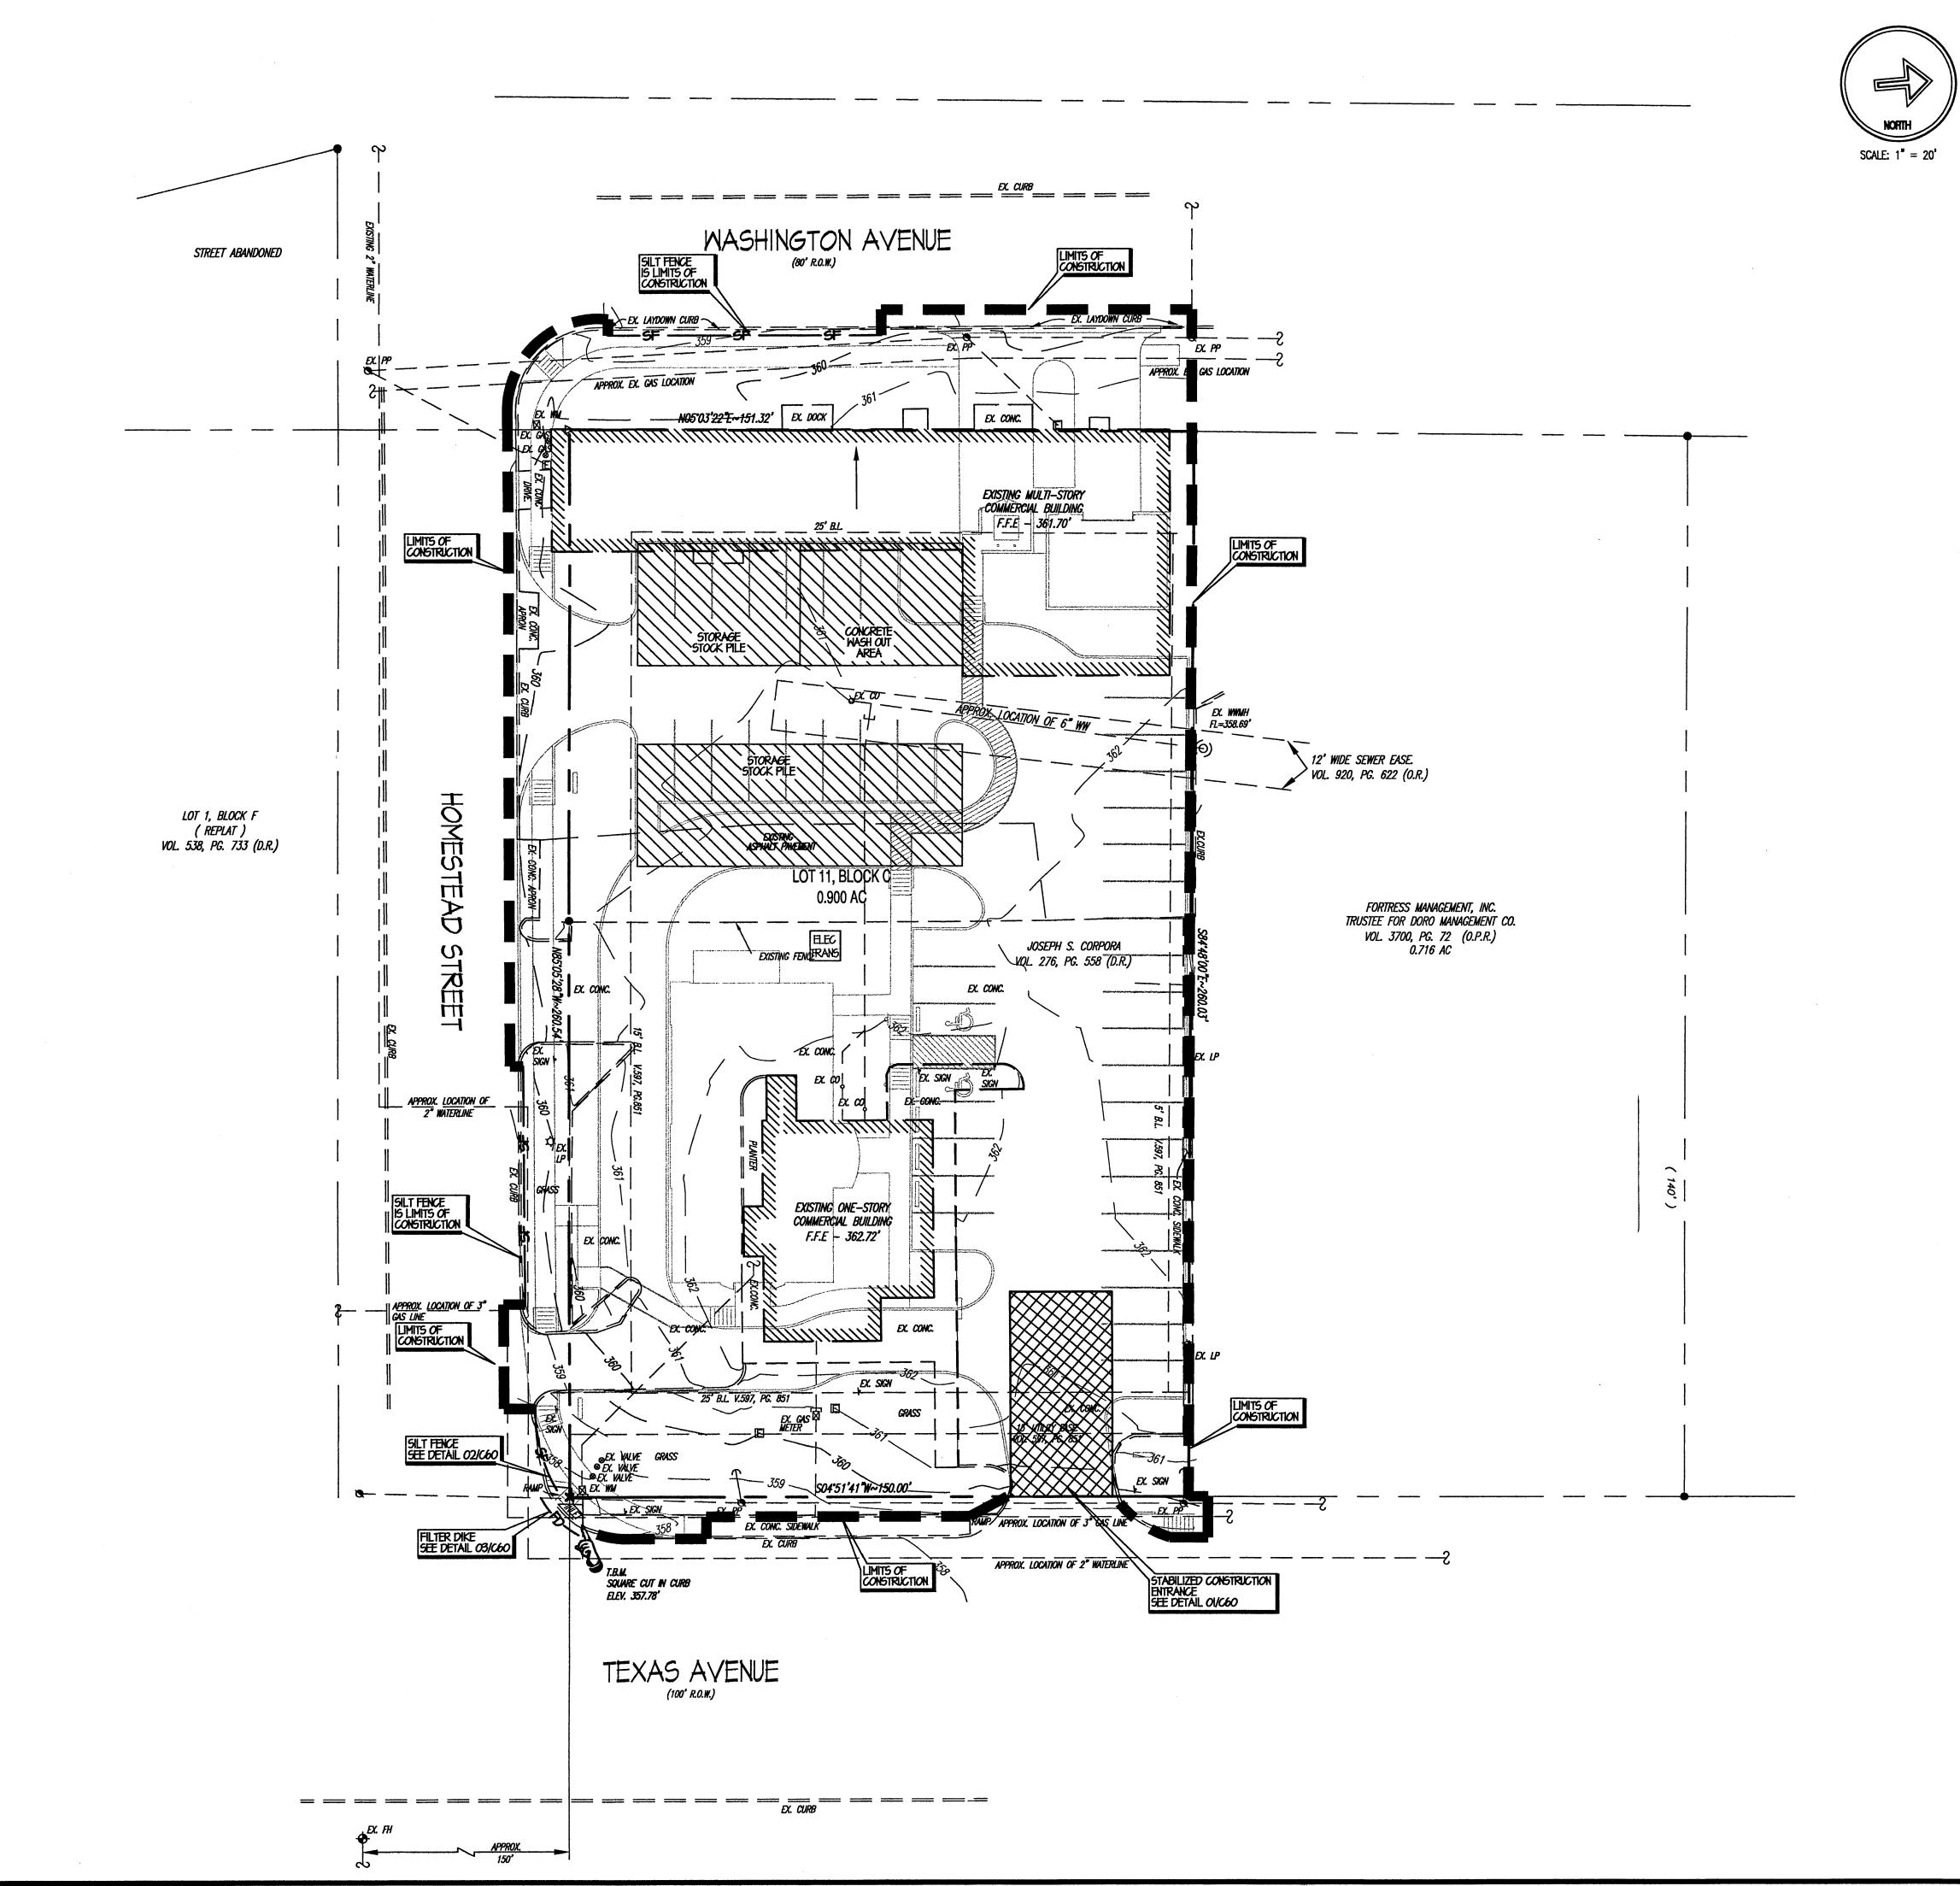



-CONTRACTOR TO ENGURE AT ALL TIMES, CONSTRUCTION TRAFFIC SHALL ENTER AND EXIT THROUGH A STABILIZED CONSTRUCTION ENTRANCE. ANY DIRT, MUD, DEBRIS, ETC. SPILLED, TRACKED OR OTHERWISE DEPOSITED ON EXISTING PAVED STREETS AND DRIVES SHALL BE IMMEDIATELY CLEANED UP.

-CONTRACTOR TO IMPLEMENT TRAFFIC CONTROL MEASURES AS REQUIRED WHEN NECESSARY.

-EROSION CONTROLS SHALL BE IN PLACE PRIOR TO ANY DEMOLITION OR CONSTRUCTION.

-THE CONTRACTOR SHALL CONSTRUCT AN ALL WEATHER SURFACE ACCESS DRIVE PRIOR TO GOING VERTICAL WITH THE BUILDING STRUCTURE. DIRT WORK AND FOUNDATION WORK MAY BE DONE PRIOR TO THE CONSTRUCTION OF THIS REGUIREMENT. ALL WEATHER SURFACE IS DEFINED AS ASPHALT, CONCRETE OR CHIP SEAL OVER AN ENGINEERED COMPACTED BASE.


-THE CONTRACTOR SHALL BE RESPONSIBLE FOR THE CONTAINMENT AND PROPER DISPOSAL OF ALL LIQUID AND SOLID WASTE ASSOCIATED WITH THIS PROJECT.

-THE CONTRACTOR SHALL USE ALL MEANS NECESSARY TO PREVENT THE OCCURRENCE OF WIND BLOWN LITTER FROM THE PROJECT SITE.

.262 .265

SOCIATION & PLANN




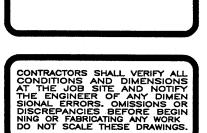

AVENUE 77803 BELL 00 20 S. BRY.


EROSION/SEDIMENTATION CONTROL PLAN


ALL RESPONSIBILITY FOR THE ADEQUACY OF THESE PLANS REMAINS WITH THE ENGINEER WHO PREPARED THEM. IN REVIEWING THESE PLANS, THE CITY OF AUSTIN MUST RELY UPON THE ADEQUANCE OF THE WORK OF THE DESIGN ENGINEER.

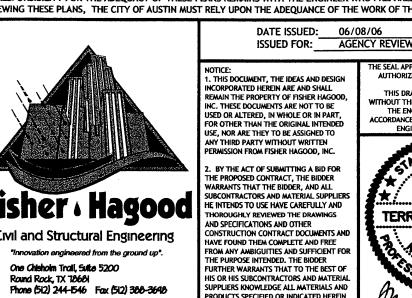

2. BY THE ACT OF SUBMITTING A BID FOR THE PROPOSED CONTRACT, THE BIDDER WARRANTS THAT THE BIDDER, AND ALL SUBCONTRACTORS AND MATERIAL SUPPLIE HE INTENDS TO USE HAVE CAREFULLY AND THOROUGHLY REVIEWED THE DRAWINGS AND SPECIFICATIONS AND OTHER CONSTRUCTION CONTRACT DOCUMENTS AN HAVE FOUND THEM COMPLETE AND FREE FROM ANY AMBIGUITIES AND SUFFICIENT FOR THE PURPOSE INTENDED. THE BIDDER FURTHER WARRANTS THAT TO THE BEST OHIS OR HIS SUBCONTRACTORS AND MATERIA. SUPPLIERS KNOWLEDGE ALL MATERIALS AN PRODUCTS SPECIFIED OR INDICATED HEREI ARE ACCEPTABLE FOR ALL APPLICABLE CODES AND AUTHORITIES.

REVISIONS PROJECT NO. 25120
CAD FILE 25120C21
DRAWN BY CMB
CHECKED BY TRH
DATE: 06/08/06
SCALE: AS NOTED

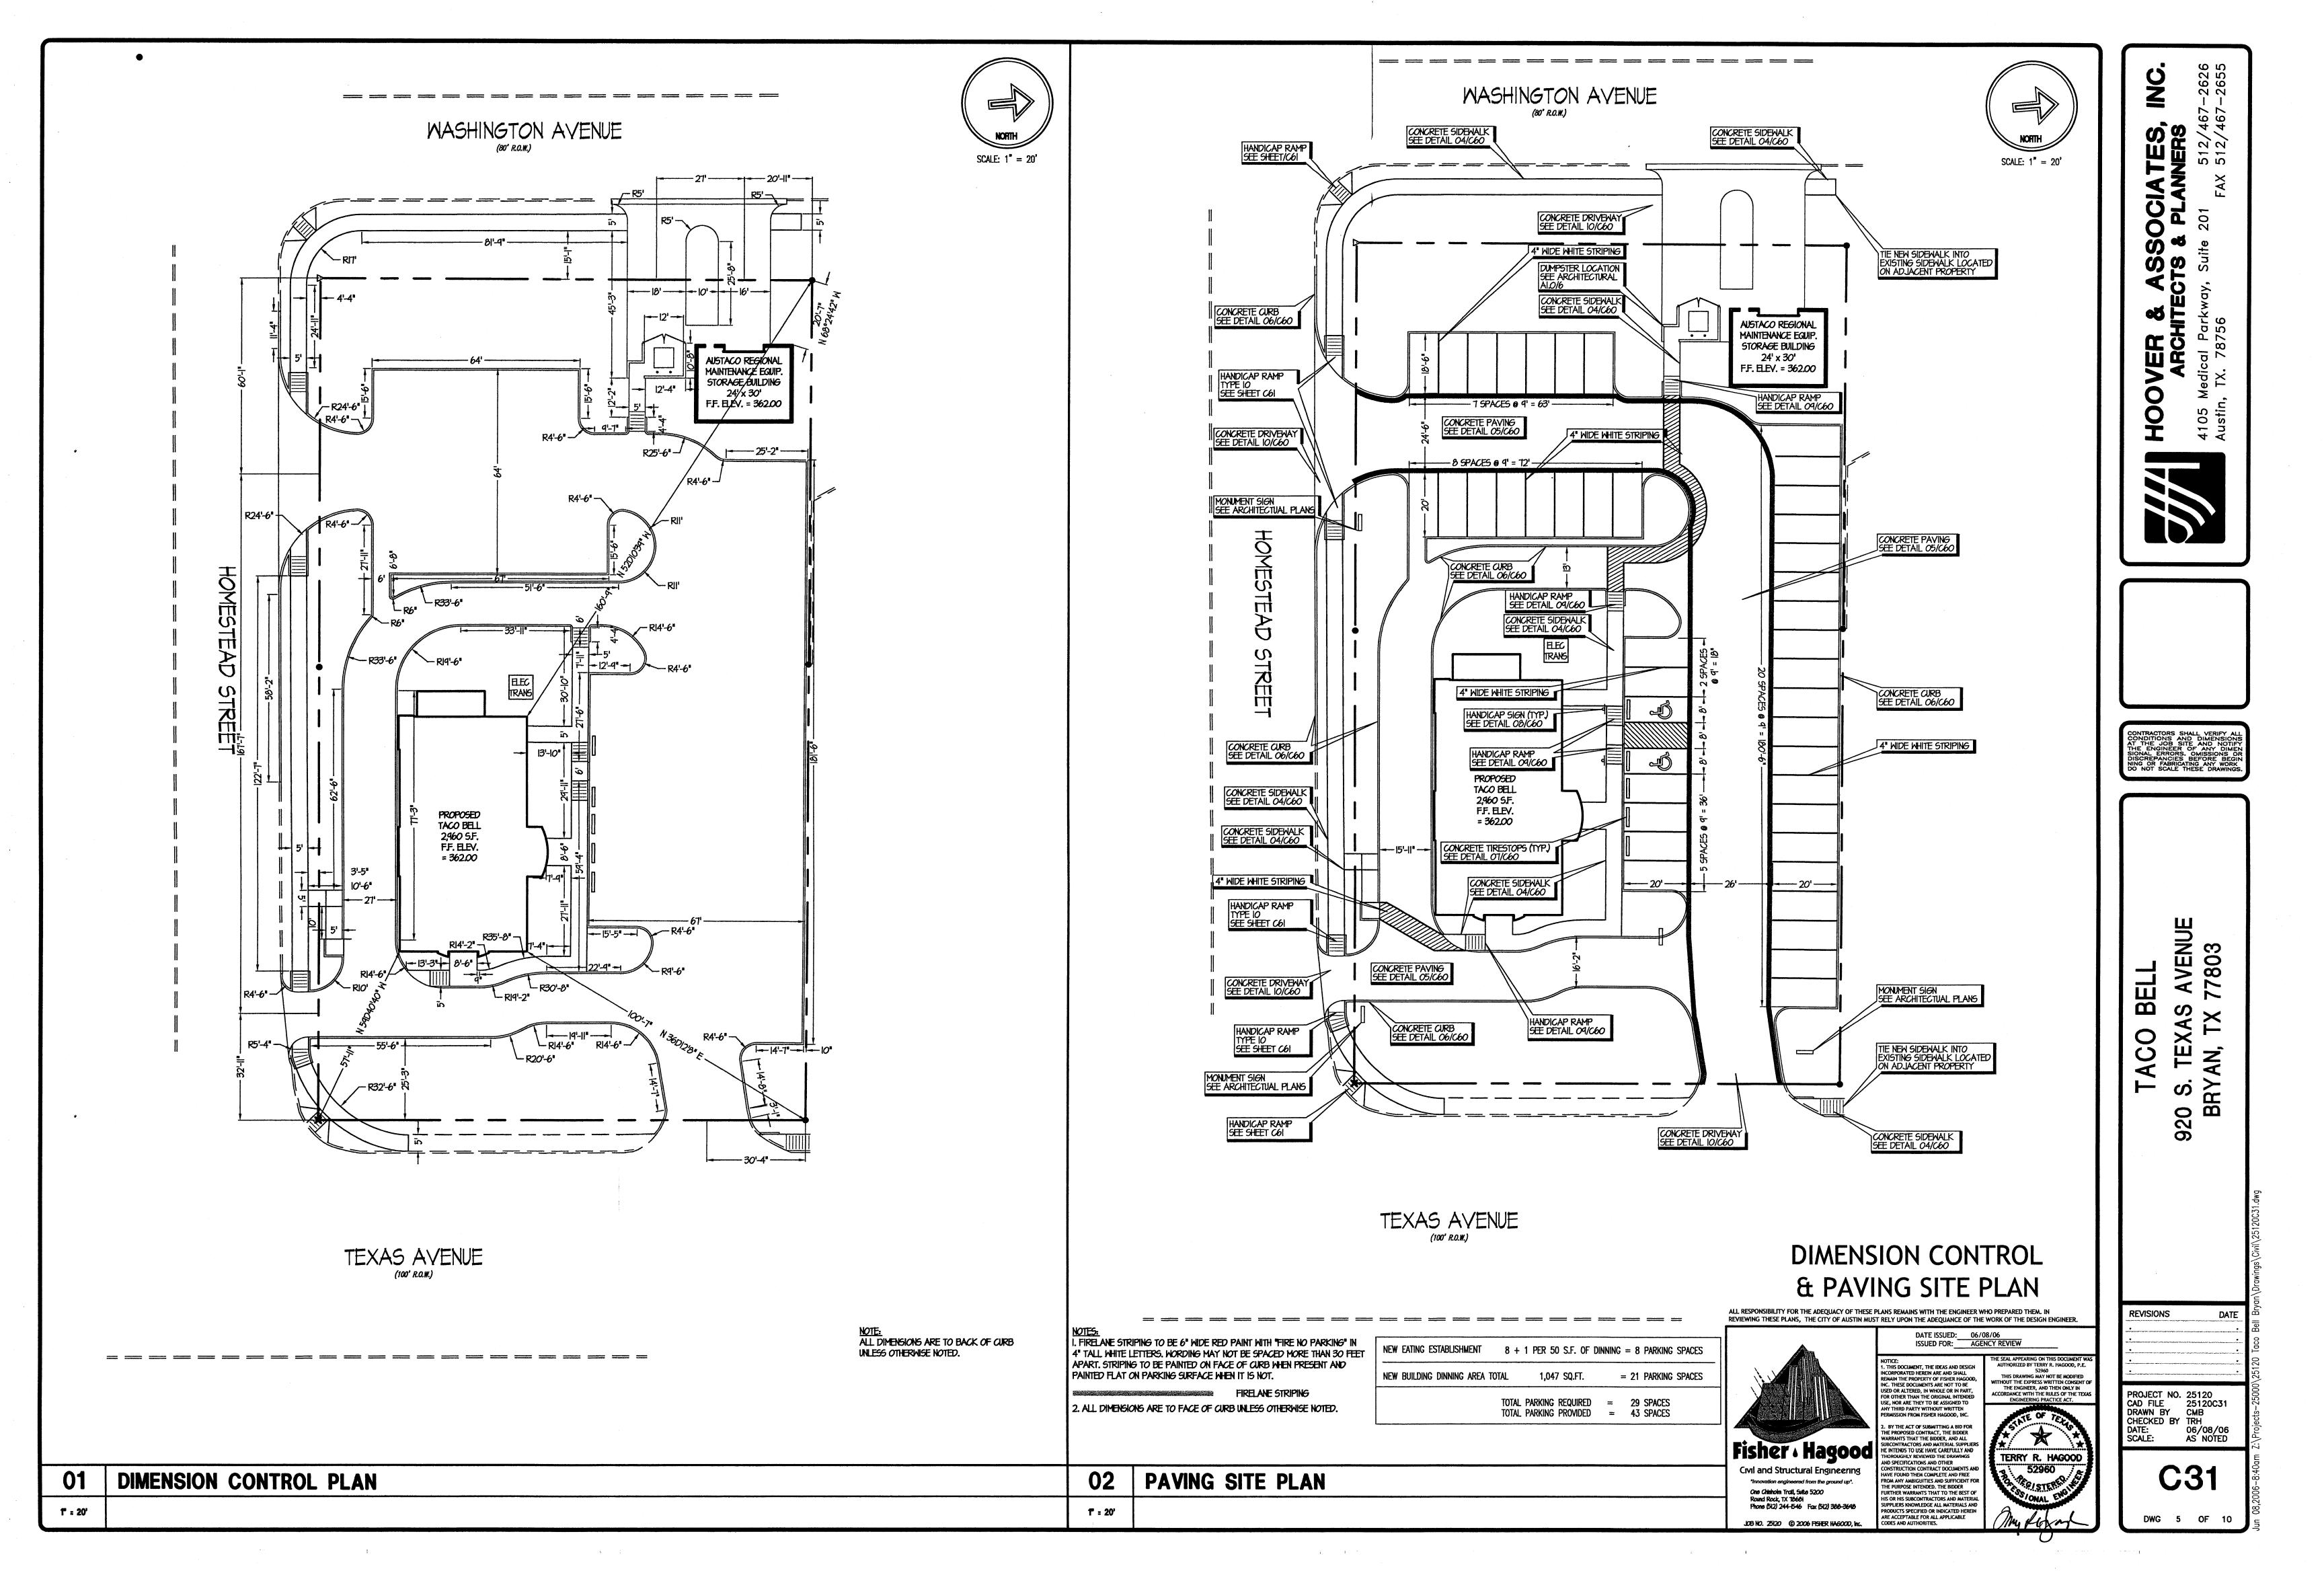

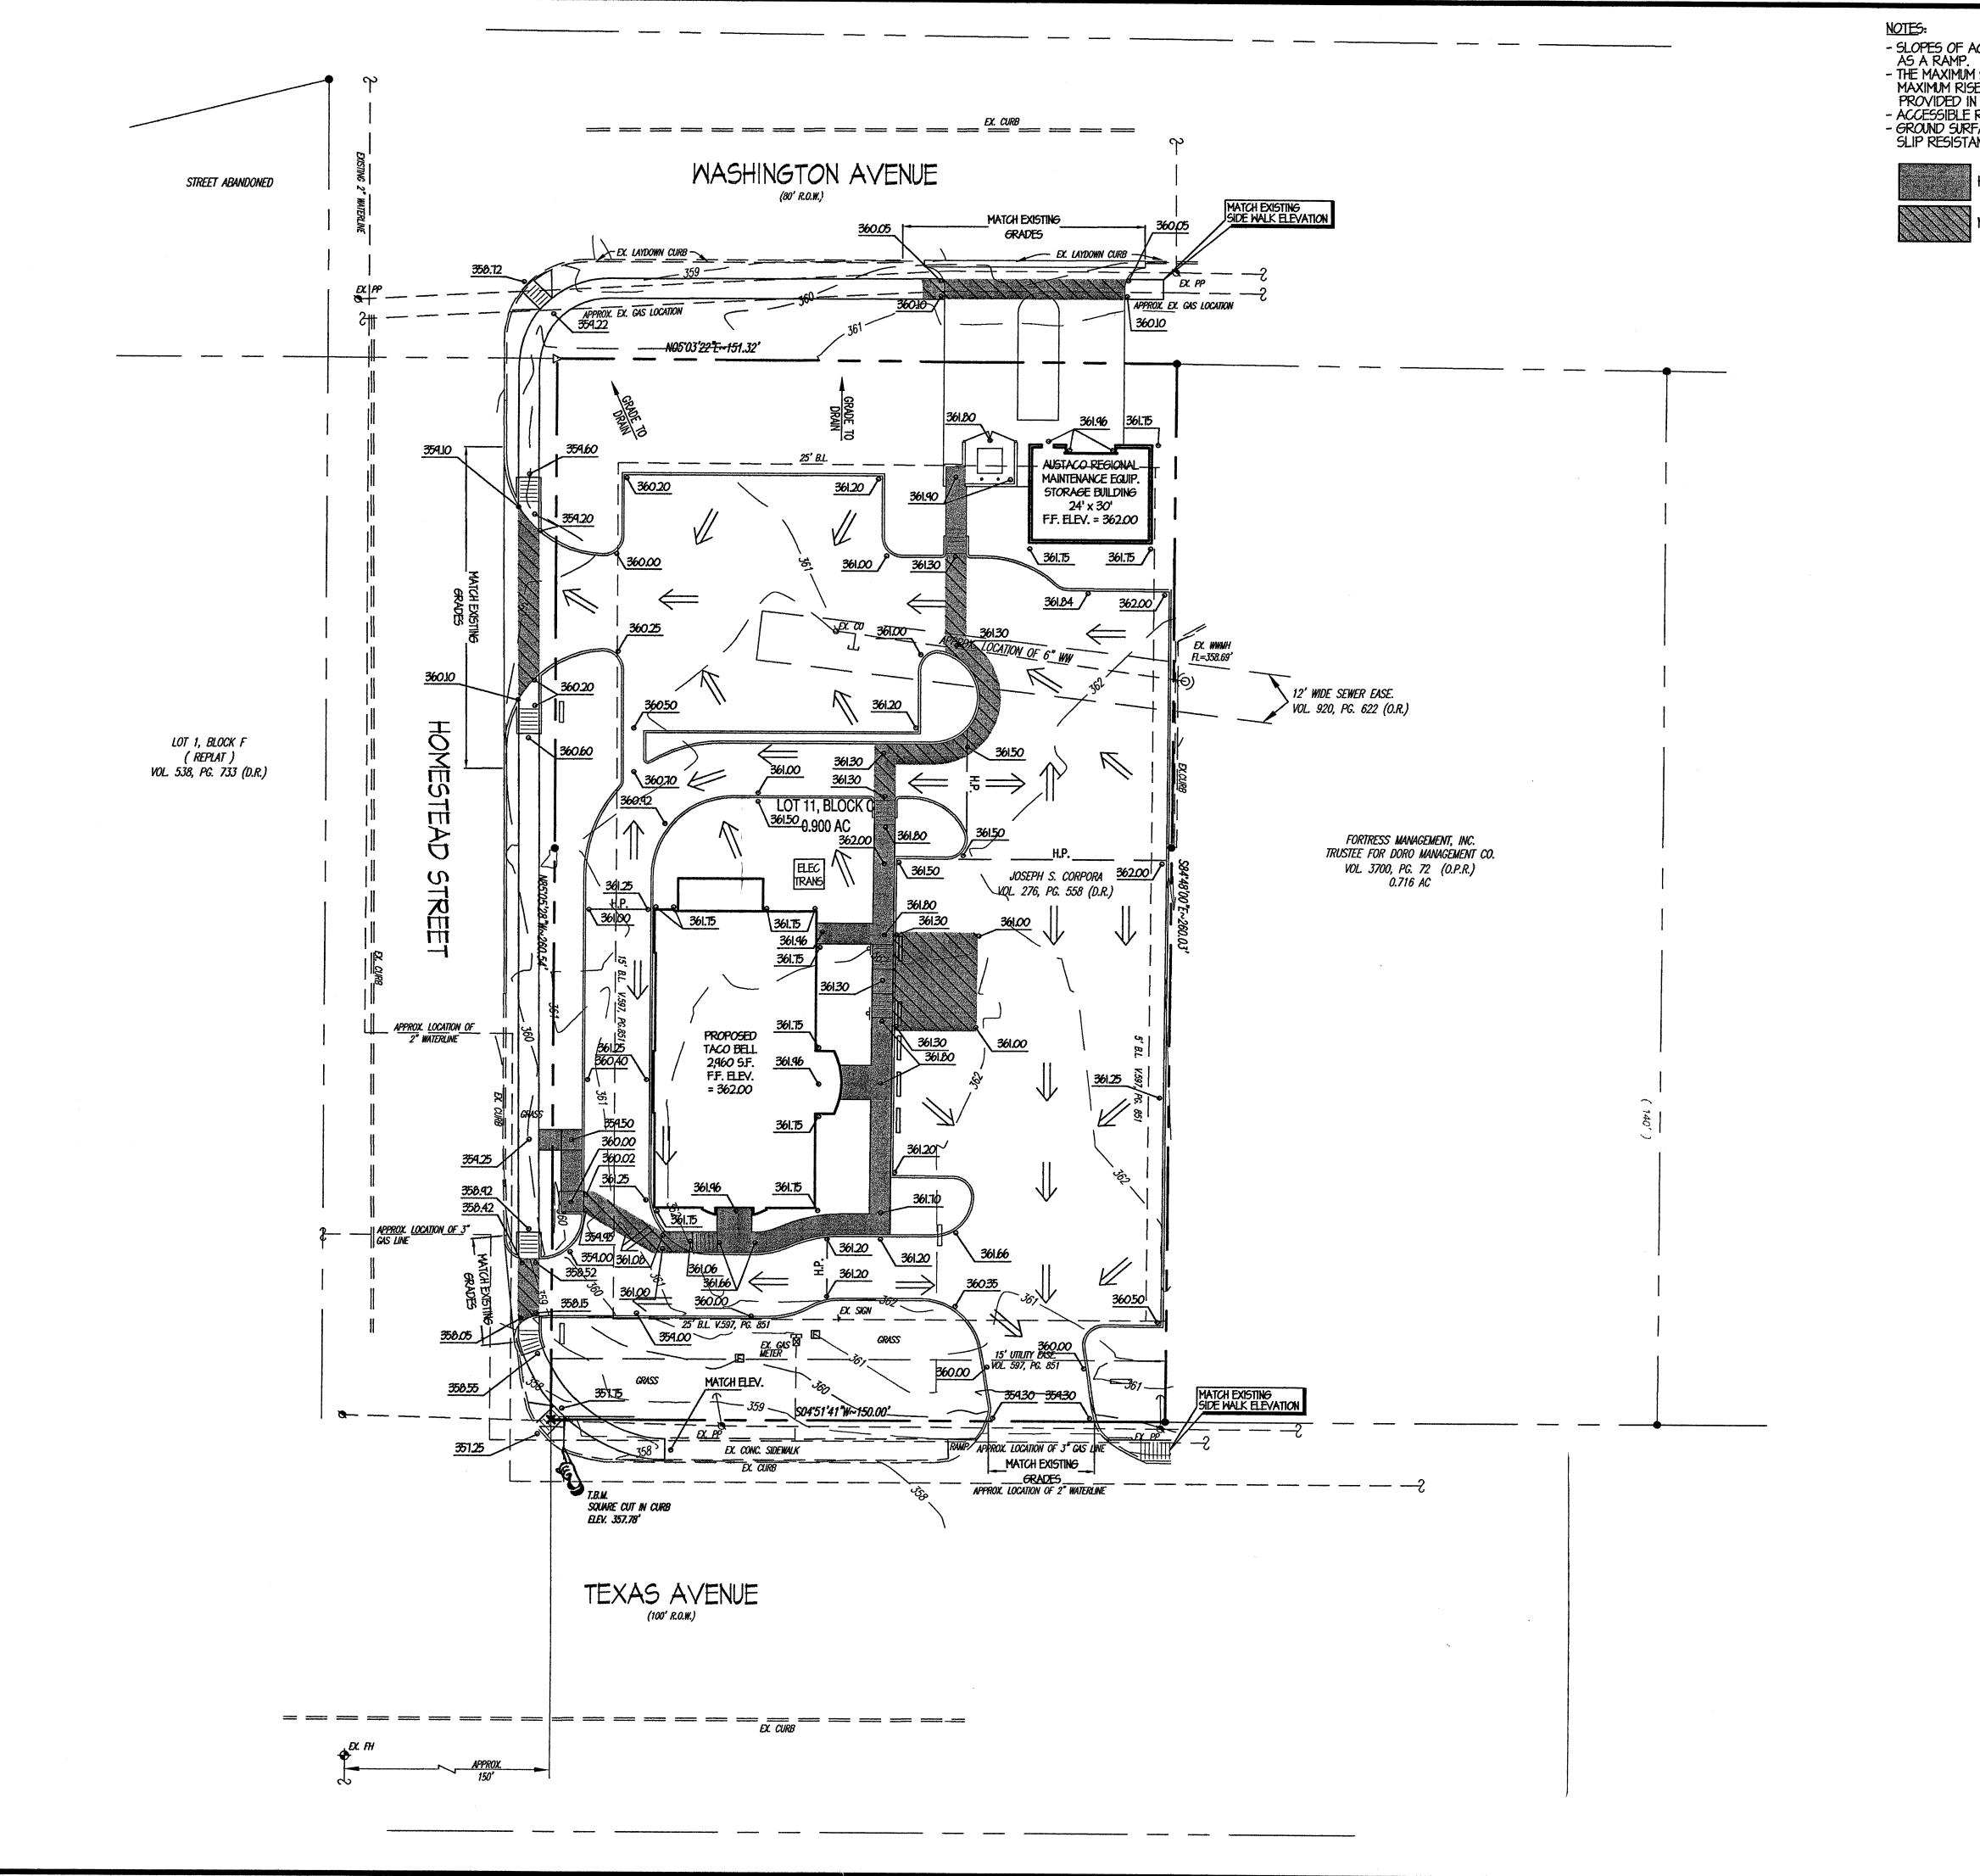

- SLOPES OF ACCESSIBLE ROUTES MAY NOT EXCEED 1:20 UNLESS DESIGNED AS A RAMP.

 THE MAXIMUM SLOPE OF A RAMP IN NEW CONSTRUCTION IS 1:12. THE MAXIMUM RISE FOR ANY RAMP RUN IS 30 in. HANDRAILS SHALL BE PROVIDED IN ACCORDANCE WITH TDLR REQUIREMENTS FOR ALL RAMPS.

 ACCESSIBLE ROUTES MUST HAVE A CROSS-SLOPE NO GREATER THAN 1:50.

 GROUND SURFACE ALONG ACCESSIBLE ROUTES MUST BE STABLE, FIRM AND SLIP RESISTANT.




SCALE: I" = 20'

HANDICAP ACCESSIBLE ROUTE

NO SLOPES GREATER THAN 2% ANY DIRECTION IN THIS AREA.



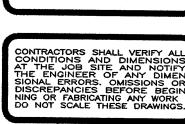

0 AC 920

DRAINAGE SITE PLAN ALL RESPONSIBILITY FOR THE ADEQUACY OF THESE PLANS REMAINS WITH THE ENGINEER WHO PREPARED THEM. IN REVIEWING THESE PLANS, THE CITY OF AUSTIN MUST RELY UPON THE ADEQUANCE OF THE WORK OF THE DESIGN ENGINEER.

THE SEAL APPEARING ON THIS DOCUMENT W AUTHORIZED BY TERRY R. HAGOOD, P.E. 52960 THIS DRAWING MAY NOT BE MODIFIED WITHOUT THE EXPRESS WRITTEN CONSENT O THE ENGINEER, AND THEN ONLY IN ACCORDANCE WITH THE RULES OF THE TEX

GRADING/

NOTICE:

1. THIS DOCUMENT, THE IDEAS AND DESIGN INCORPORATED HEREIN ARE AND SHALL REMAIN THE PROPERTY OF FISHER HAGOOD INC. THESE DOCUMENTS ARE NOT TO BE USED OR ALTERED, IN WHOLE OR IN PART, FOR OTHER THAN THE ORIGINAL INTENDED USE, NOR ARE THEY TO BE ASSIGNED TO ANY THIRD PARTY WITHOUT WRITTEN PERMISSION FROM FISHER HAGOOD, INC.

2. BY THE ACT OF SUBMITTING A BID FOR THE PROPOSED CONTRACT, THE BIDDER WARRANTS THAT THE BIDDER, AND ALL SUBCONTRACTORS AND MATERIAL SUPPLIES HE INTENDS TO USE HAVE CAREFULLY AND THOROUGHLY REVIEWED THE DRAWINGS AND SPECIFICATIONS AND OTHER CONSTRUCTION CONTRACT DOCUMENTS AND HAVE FOUND THEM COMPLETE AND FREE FROM ANY AMBIGUITIES AND SUFFICIENT FOR THE PURPOSE INTENDED. THE BIDDER FURTHER WARRANTS THAT TO THE BEST OF HIS OR HIS SUBCONTRACTORS AND MATERIAL SUPPLIES KNOWLEDGE ALL MATERIALS AND PRODUCTS SPECIFIED OR INDICATED HEREIN ARE ACCEPTABLE FOR ALL APPLICABLE CODES AND AUTHORITIES.


Fisher · Hagood

Civil and Structural Engineering "Innovation engineered from the ground up". One Chisholm Trail, Suite 5200 Round Rock, TX 1868; Phone (512) 244-1546 Fax (512) 388-3648

JOB NO. 25120 © 2006 FISHER HAGOOD, Inc

DATE ISSUED: 06/08/06
ISSUED FOR: AGENCY REVIEW

PROJECT NO. 25120
CAD FILE 25120C41
DRAWN BY CMB
CHECKED BY TRH
DATE: 06/08/06
SCALE: AS NOTED

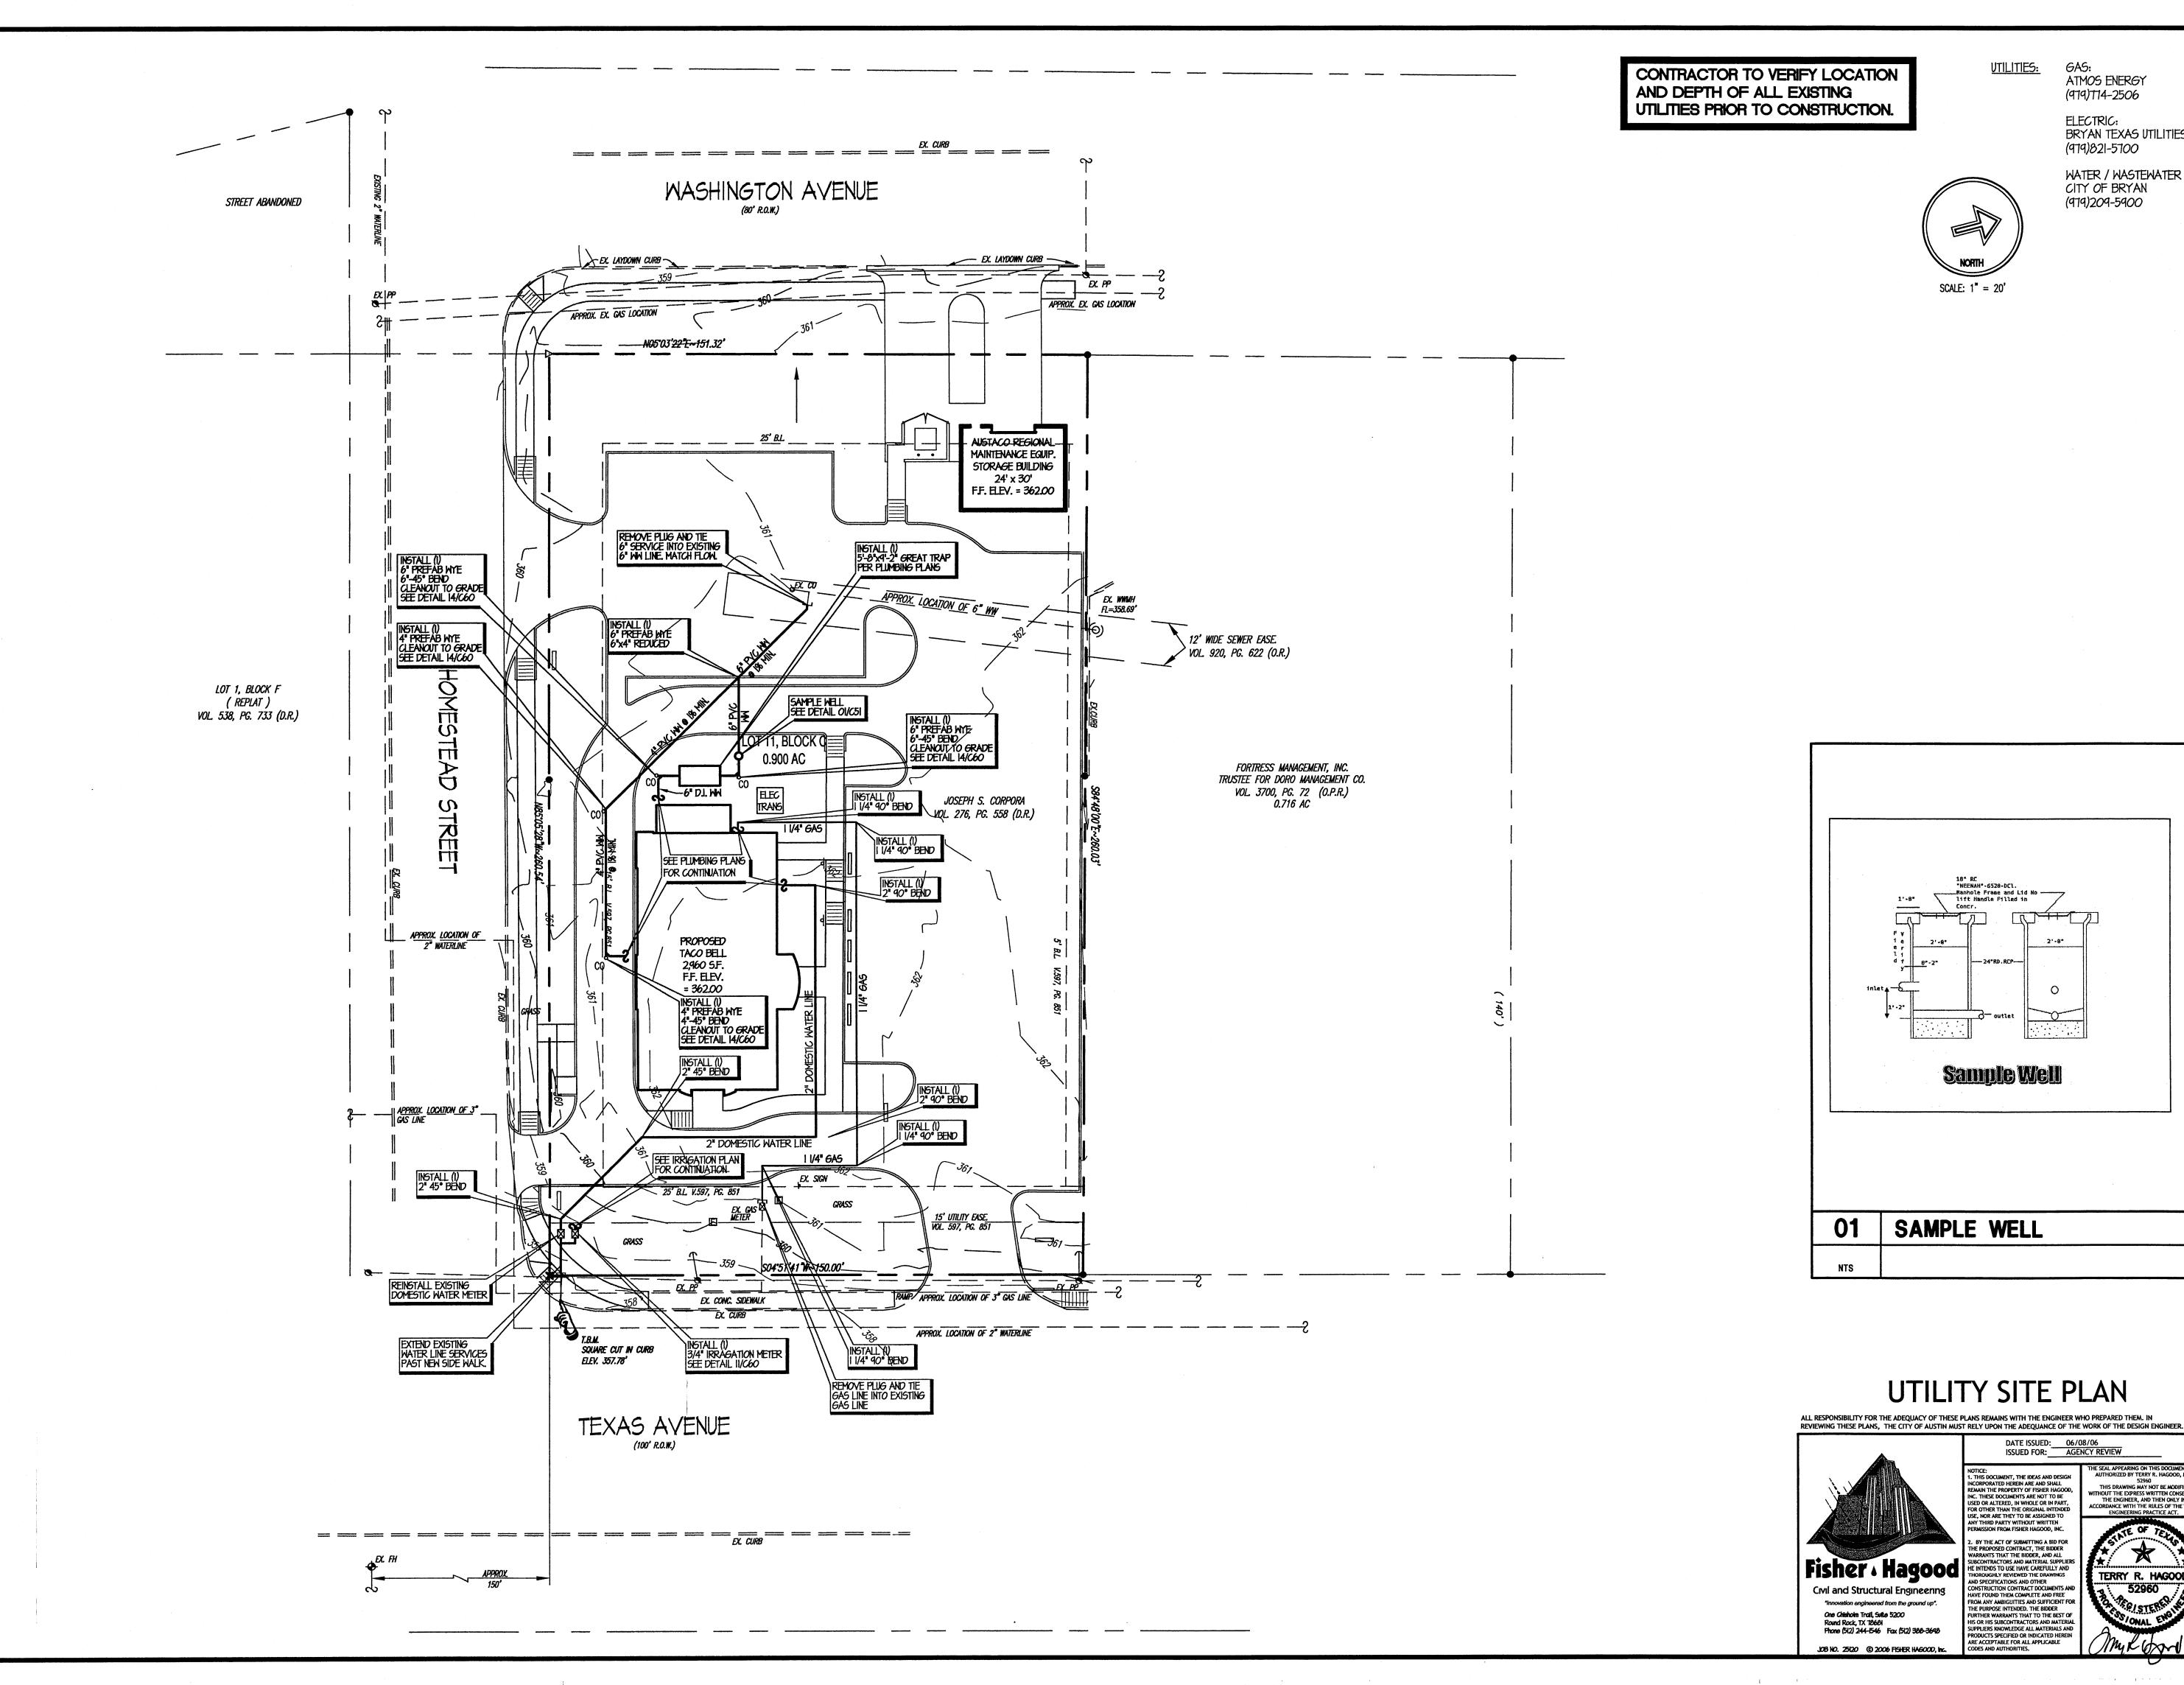

<u>UTILITIES:</u>

ATMOS ENERGY

(979)774-2506 **ELECTRIC:** BRYAN TEXAS UTILITIES .2626 .2655


512/467-512/467-

SOCIA & PLAN

(979)821-5700 WATER / WASTEWATER CITY OF BRYAN




(979)209-5900

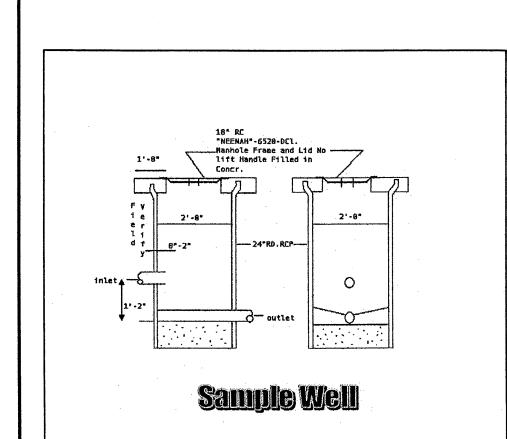


SAMPLE WELL

UTILITY SITE PLAN

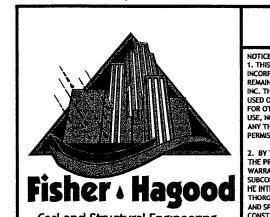

NOTICE:

1. THIS DOCUMENT, THE IDEAS AND DESIGN INCORPORATED HEREIN ARE AND SHALL REMAIN THE PROPERTY OF FISHER HAGOOD, INC. THESE DOCUMENTS ARE NOT TO BE USED OR ALTERED, IN WHOLE OR IN PART, FOR OTHER THAN THE ORIGINAL INTENDED USE, NOR ARE THEY TO BE ASSIGNED TO ANY THIRD PARTY WITHOUT WRITTEN PERMISSION FROM FISHER HAGOOD, INC. 2. BY THE ACT OF SUBMITTING A BID FOR THE PROPOSED CONTRACT, THE BIDDER WARRANTS THAT THE BIDDER, AND ALL SUBCONTRACTORS AND MATERIAL SUPPLIERS HE INTENDS TO USE HAVE CAREFULLY AND THOROUGHLY REVIEWED THE DRAWINGS AND SPECIFICATIONS AND OTHER CONSTRUCTION CONTRACT DOCUMENTS AND HAVE FOUND THEM COMPLETE AND FREE FROM ANY AMBIGUITIES AND SUFFICIENT FOR THE PURPOSE INTENDED. THE BIDDER FURTHER WARRANTS THAT TO THE BEST OF HIS OR HIS SUBCONTRACTORS AND MATERIAL SUPPLIERS KNOWLEDGE ALL MATERIALS AND PRODUCTS SPECIFIED OR INDICATED HEREIN ARE ACCEPTABLE FOR ALL APPLICABLE CODES AND AUTHORITIES. Civil and Structural Engineering "Innovation engineered from the ground up". One Chisholm Trail, Suite 5200 Round Rock, TX 18681 Phone (512) 244-1546 Fax (512) 388-3648

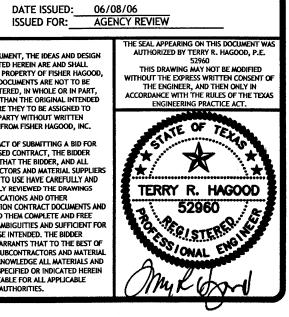

PROJECT NO. 25120
CAD FILE 25120C51
DRAWN BY CMB
CHECKED BY TRH
DATE: 06/08/06
SCALE: AS NOTED

REVISIONS

AVENUE 77803

20 S. BRY

BELL

TAC0

C51